


Drawn By: Approved By: AEM/MEP

202416



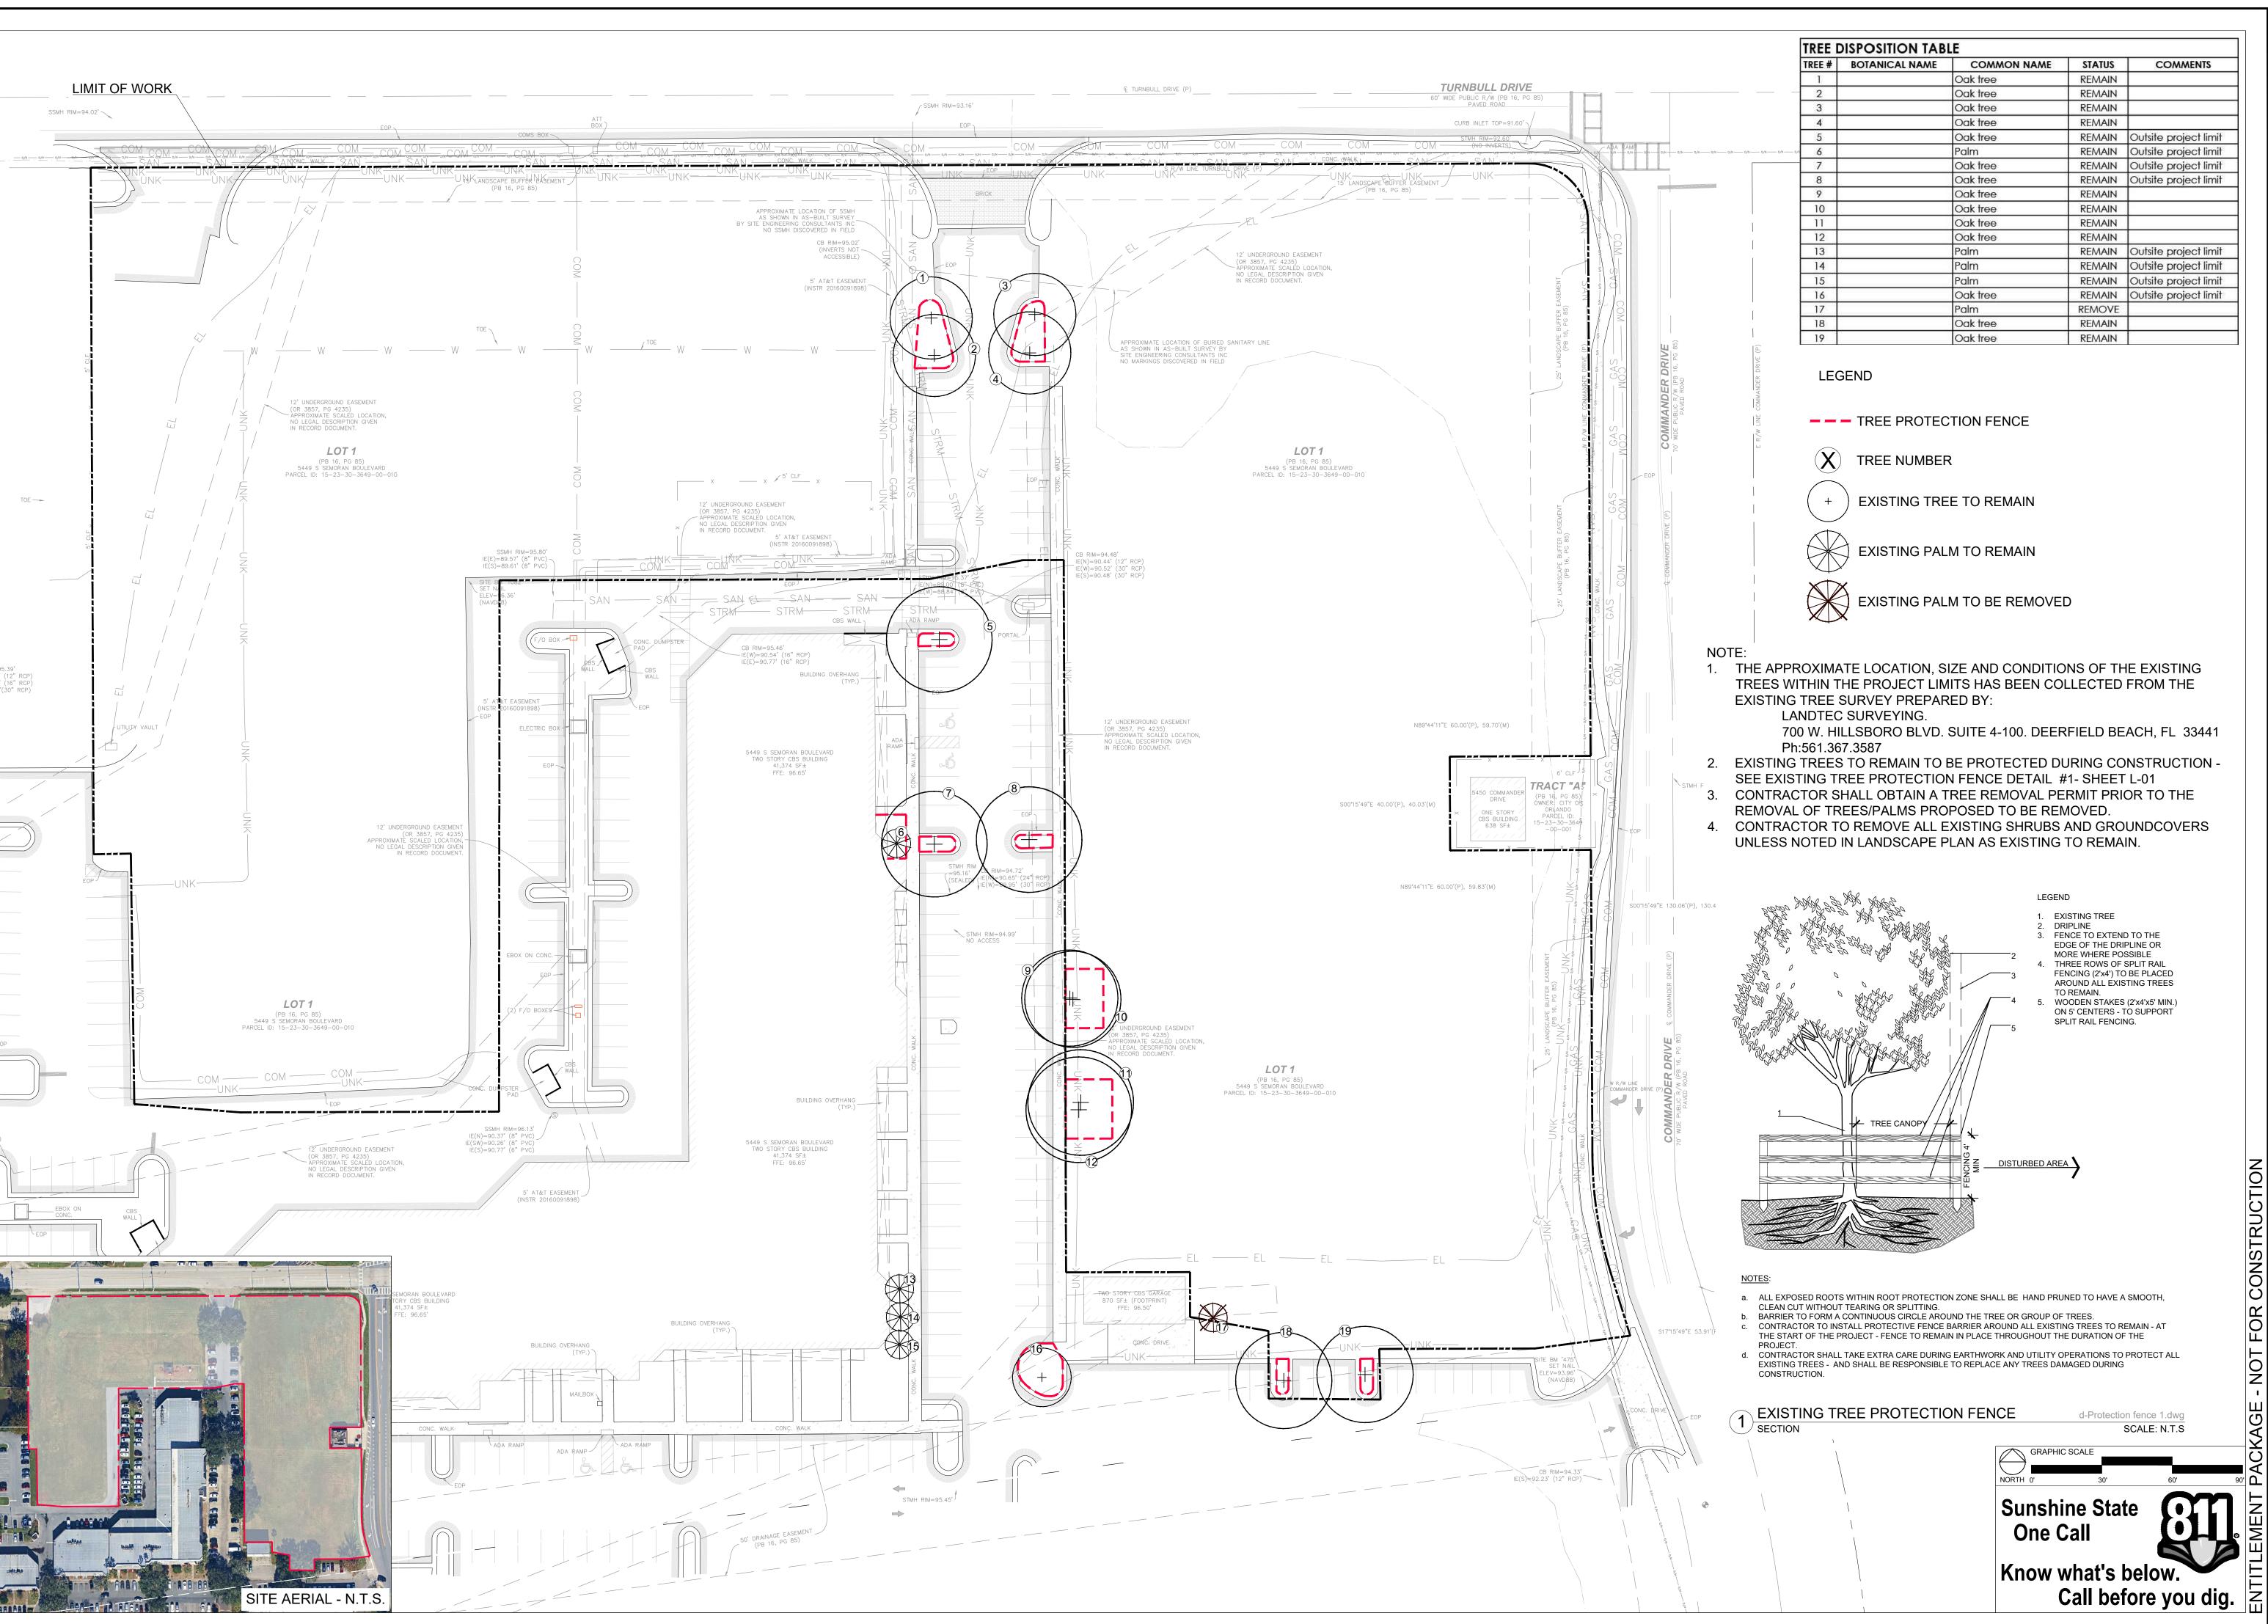

LANDSCAPE ARCHITECTURE
LAND PLANNING
URBAN DESIGN
2300 E. OAKLAND PARK BLVD. SUITE 300
FORT LAUDERDALE, FLORIDA 33306 USA
TEL: 954.533.8259
www.amlastudio.com

Date: Description: By:

PROPERTY SURVEY 8
TREE DISPOSITION
PLAN

OFFNER COMMONS
APARTMENTS
5449 S. SEMORAN BLVD.

STATE OF FLORIDA REGISTRATION LA6666973

SEAL / SIGNATURE

ESIGNS AND DETAILS ON THIS DRWAWING ARE THE
RRTY OF ANDRES MONTERO LANDSCAPE
TECTURE, LLC. AND SHALL NOT BE USED, COPIED
PRODUCED WITHOUT WRITTEN PERMISSION FROM
SES MONTERO LANDSCAPE ARCHITECTURE, LLC.

or REPRODUCED WITHOUT WRITTEN PERMISSION FROM ANDRES MONTERO LANDSCAPE ARCHITECTURE, LLC.

Date: APRIL 17, 2025


Scale: 1" = 30'-0"

Drawn By: AEM/MEP

Approved By: AEM

Project No: 202416

Sheet Number:

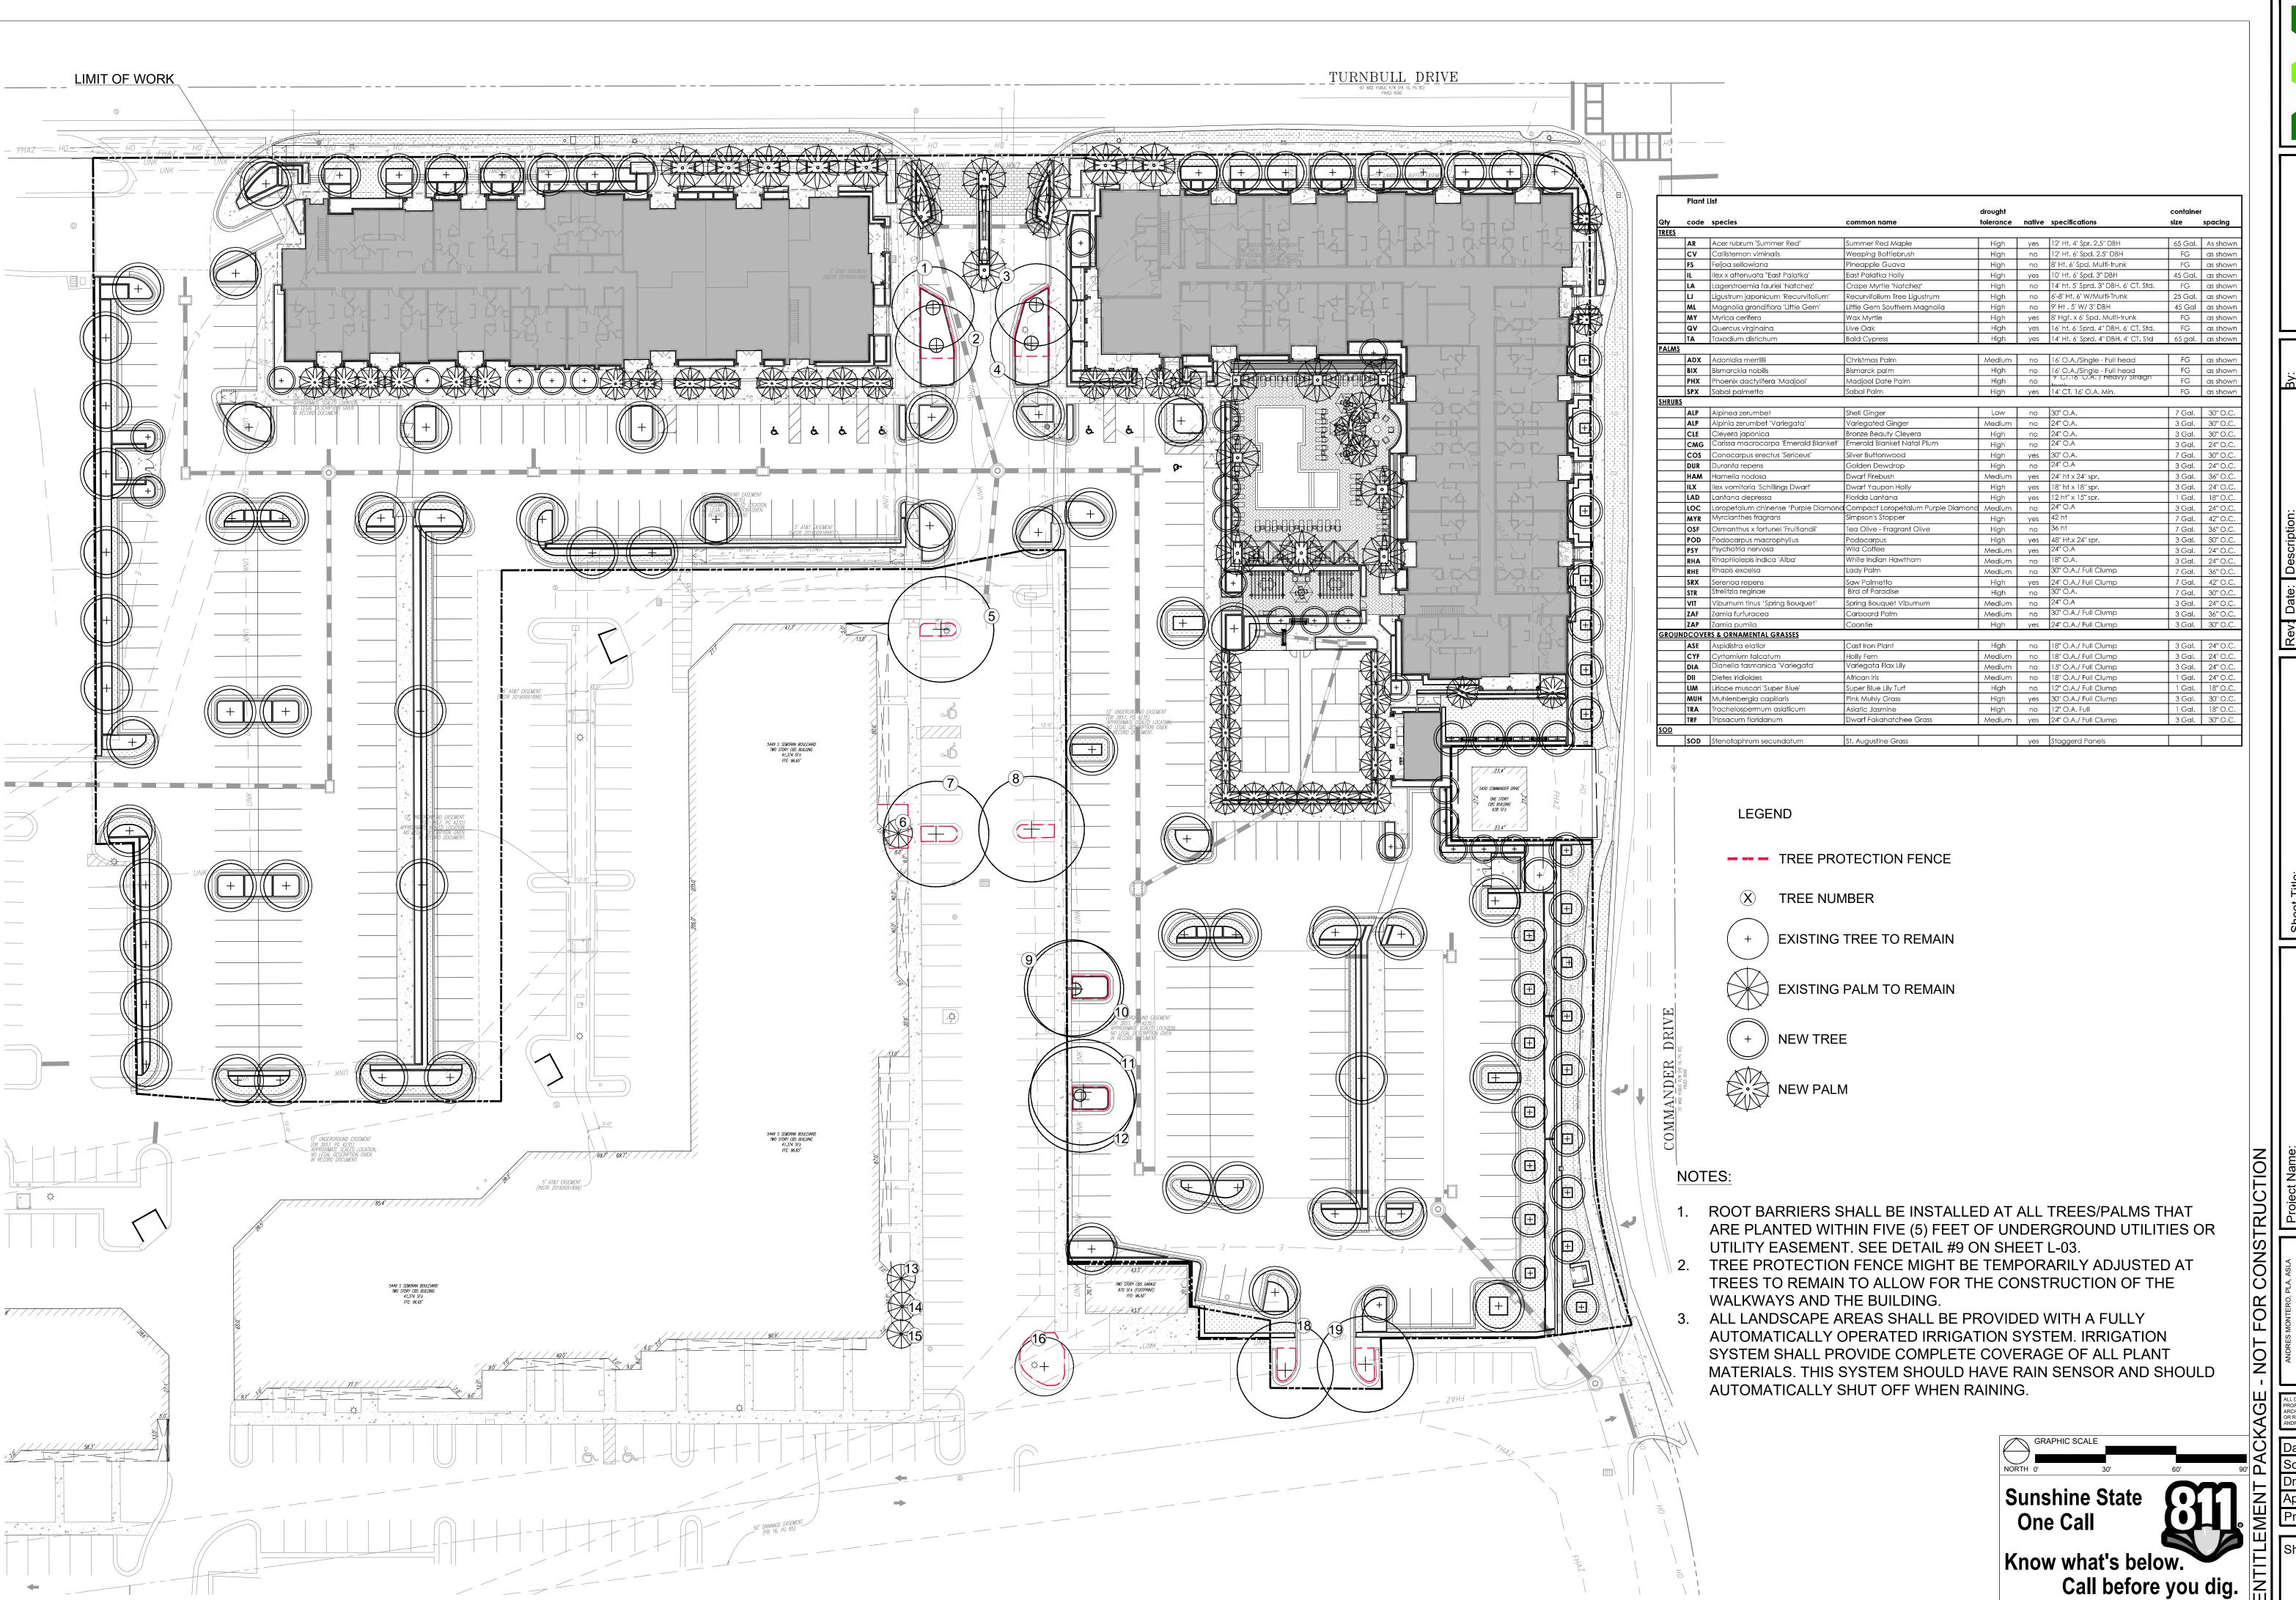



LANDSCAPE ARCHITECTURE
LAND PLANNING
URBAN DESIGN
2300 E. OAKLAND PARK BLVD. SUITE 300
FORT LAUDERDALE, FLORIDA 33306 USA
TEL: 954.533.8259
www.amlastudio.com

: Date: Description: By:

/ERALL PRELIMINARY LANDSCAPE PLAN

APARTMENTS

APARTMENTS

STATE OF FLORIDA
REGISTRATION LA6666973

SEAL / SIGNATURE

SIGNS AND DETAILS ON THIS DRWAWING ARE THIS PROPERTY OF ANDRES MONTERO LANDSCAPE
TECTURE, LLC. AND SHALL NOT BE USED, COPIED PRODUCED WITHOUT WRITTEN PERMISSION FROM SEMONTERO LANDSCAPE ARCHITECTURE, LLC.

Date: APRIL 17, 2025

Scale: 1" = 30'-0"

Drawn By: AEM/MEP


Approved By: AEM

Project No: 202416

Sheet Number:


GENERAL NOTES:

- 1. Before construction begins, the Landscape Contractor is responsible for locating all underground utilities and must avoid damaging any services during construction. If any damage occurs by the fault of the Contractor, the necessary repairs must take place at the Landscape Contractor's expense and under the supervision of the Owner's representative.
- 2. The Landscape Contractor shall be responsible for securing all necessary applicable permits and licenses to perform the work set forth in this plan set and the specifications.
- 3. The Landscape Contractor shall be responsible for examining fully both the site and bid documents. Discrepancies in the documents or the actual site conditions shall be reported to the Landscape Architect in writing at the time of bidding or discovery. No account shall be made after contract completion for failure by the Landscape Contractor to report such condition or for errors on the part of the Landscape Contractor at the time of bidding.
- 4. All dimensions to be field checked by the Landscape Contractor prior to landscape material installation. Discrepancies shall be reported immediately to the Landscape Architect.
- 5. Contractor shall be responsible for removing all existing and imported limerock and limerock sub-base from all landscape planting areas to a minimum depth of 36" or to native soil. Contractor is responsible to backfill these planting areas to rough finished grade with clean topsoil from an on-site source or an imported source.
- 6. All planting beds shall be excavated to a minimum size and depth as shown in the planting details for trees, shrubs, and groundcovers, and backfilled with suitable soil unless specified otherwise. All plant material shall be planted in planting soil that is delivered to the site in a loose, clean, and friable condition. The planting soil shall be of the approximate proportions as follows: 50% sand and 50% organic material consisting of native peat, well-decomposed sawdust, leaf mold and topsoil. It shall provide a good, pliable, and thoroughly mixed medium with adequate aeration, drainage, and water-holding capacity. It shall also be free of all extraneous debris, such as roots, stones, weeds, etc.
- 7. Contractor to test all tree pits with water before planting to assure proper drainage percolation is
- 8. All proposed trees and plant materials shall be graded as Nursery Grade Florida No. 1 or better as outlined by the Florida Department of Agriculture and Consumer Services, Division of Plant Industry "Grades and standards for Nursery Plants", most current edition. All planting shall be done in accordance with the Florida Nurserymen's and Grower's Association approved practices.
- 9. All trees/palms and shrubs shall be fertilized with "Agriform" 20-10-5 planting tablets as per the manufacturer's specifications at the time of installation and prior completion of pit backfilling also in conjunction with note #5. Tablets to be placed uniformly around the root mass at a depth that is between the middle and bottom of root mass at an application rate of: One (1) - 21 gram tablet for 1 gal container, two (2)- tablets for 3 gal container, three (3)- tablets for 5 gal container, four (4)-tablets for 7 gal container, three (3)-tablets for each 1/2 inch of tree caliper, and seven (7) tablets for palms. Ground Cover areas shall receive fertilization with "Ozmocote" time release fertilizer as per manufacturer's specification.
- 10. All plant beds shall receive a 3" layer of organic mulch, which is to be watered-in after installation. Mulch should be at least six (6) inches away from any portion of a structure or tree trunk and three (3) inches away from the base of shrubs. The use of Cypress mulch is discouraged.
- 11. All plant material shall be thoroughly watered in at the time of planting and until landscape material is established. No dry material shall be permitted.
- 12. The plant material schedule is presented for the convenience of the Landscape Contractor. In the event of a discrepancy between the plan and the plant list quantities, the contractor shall notify the owner's representative/Landscape Architect prior to bidding or installation of the project.
- 13. Plants shall meet size, container, and spacing specifications. Any material not meeting specifications shall be removed and replaced at the contractor's expense.
- 14. All tree and shrub locations shall be approved by Landscape Architect prior to planting.
- 15. Plant material shall be bid as specified unless unavailable, at which time the Landscape Architect shall be notified in writing of intended changes.
- 16. All guestions concerning the plan set and/or specifications shall be directed to the Landscape
- 17. All materials must be as specified on the landscape plan. If materials or labor do not adhere to specifications, they will be rejected by the Landscape Architect with proper installation carried out by the Landscape Contractor at no additional cost.
- 18. There shall be no additions, deletions, or substitutions without written approval of the Landscape Architect
- 19. All screening hedges shall be planted and maintained in a way that they form a continuous visual screen. Screening hedges at VUA to be maintained at a minimum height of thirty (30) inches unless specified otherwise to meet local codes.
- 20. The Landscape Contractor shall guarantee, in writing, plant survivability. Trees and palms for twelve (12) months, shrubs, and groundcovers for ninety (90) days and sod for sixty (60) days from final acceptance by the Owner or Owner's representative.
- 21. Existing sod shall be removed as necessary to accommodate new plantings.
- 22. All existing trees on site shall be protected from damage during construction See existing tree protection fence detail.
- 23. Any existing landscape and hardscape areas that are unnecessarily disturbed during the landscape installation shall be restored to their original conditions by the Landscape Contractor.
- 24. The Landscape Contractor will be responsible for the collection, removal, and proper disposal of all debris generated during the installation of this project.
- 25. The Landscape contractor shall fine grade all lawn and planting areas prior to plant material installation. Fine grading shall consist of final finished grading of lawn and planting areas that have been rough graded by others.
- 26. The Landscape Contractor shall grade planting beds, as required, to provide positive drainage and promote optimum plant growth. 27. Prior to sod installation, the Landscape Contractor shall clear the area of debris, weeds and remove
- any bumps and depressions within the area to be sodded. 28. All landscape areas to have a positive drainage away from buildings and structures. Finished grade of
- landscape areas to be at or below the grade of adjacent sidewalks, slabs, or VUA 29. All shade and medium trees installed within 5' of a public infrastructure shall utilize a root barrier
- system unless specified otherwise.
- 30. In addition to these requirements the Landscape Contractor shall comply with all local landscape codes and requirements as part of this base bid and contract in order to satisfy the review and approval of the governing agency.

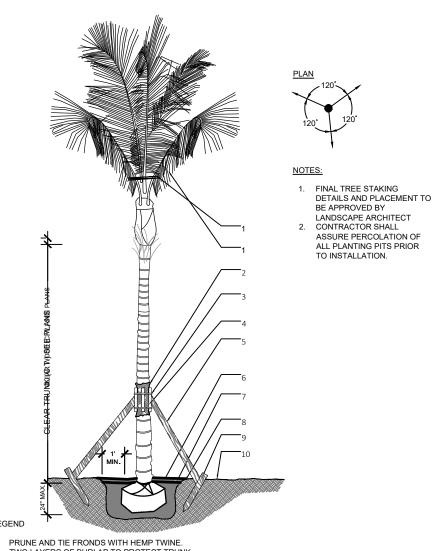

TWO LAYERS OF BURLAP TO PROTECT TRUN


- TWO STEEL BANDS TO SECURE BATTONS 3-2" X 4" LUMBER POLE BRACES. NAIL (DRILL AND NAIL IF NECESSARY) TO BATTONS & 2" X4" STAKES. FLAG
- 6. 3" MIN. MULCH- SEE SPECIFICATIONS PARED PLANTING SOIL AS SPECIFIED. PALMS SHALL BE PLANTED WITH THE TOP OF ROOTBALL AT FINISHED GRADE. BERM SOIL TO HOLD WATER
- 2 LARGE PALM

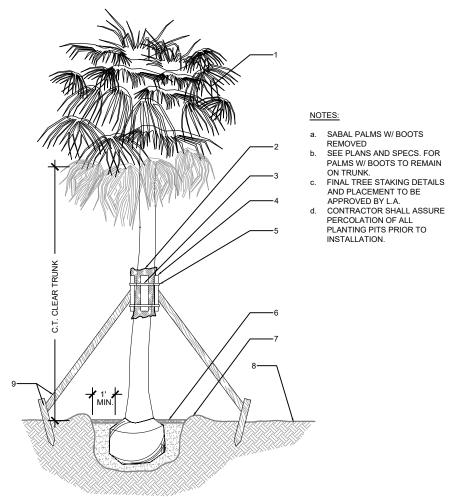


1. PRUNE AND TIE FRONDS WITH HEMP TWINE. (WASHINGTONIA PALMS REMOVE PER SPECS, HURRICANE CUT SABAL PALM). TWO LAYERS OF BURLAP TO PROTECT TRUNK

- TWO STEEL BANDS TO SECURE BATTONS. SIX 2" X 4" X 18" WOOD BATTONS PAINTED BROW 3-2" X 4" LUMBER POLE BRACE @ 120. NAIL (DRILL AND NAIL IF NECESSARY) TO BATTONS AND 2" X 4" STAKES. FLAG AT MIDPOINT.

 3" MULCH AS SPECIFIED MIN.24" FROM TRUNK
- BERM SOIL TO HOLD WATER FINISH GRADI 9. 2" X 4" WOOD STAKES
- 3 SABAL PALM SECTION SCALE: N.T.S

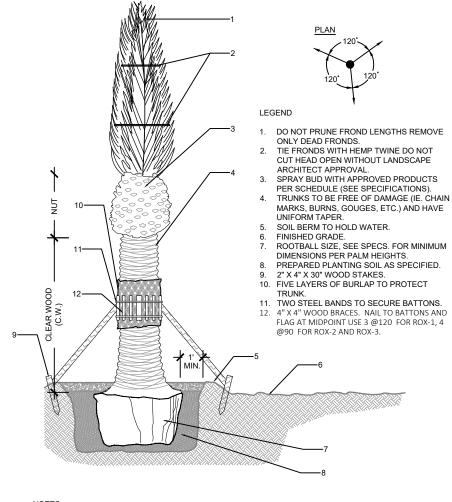


- a. CONTRACTOR TO ASSURE DRAINAGE/PERCOLATION OF PLANTING PIT PRIOR TO INSTALLATION.
 b. CONTRACTOR TO STAKE LOCATION OF PALMS FOR ANDSCAPE ARCHITECT'S APPROVAL PRIOR TO INSTALLATION.
 c. STAKE PALMS (8+ C.W.) PER STAKING DETAIL.
- 4 DATE PALM SECTION SCALE: N.T.S

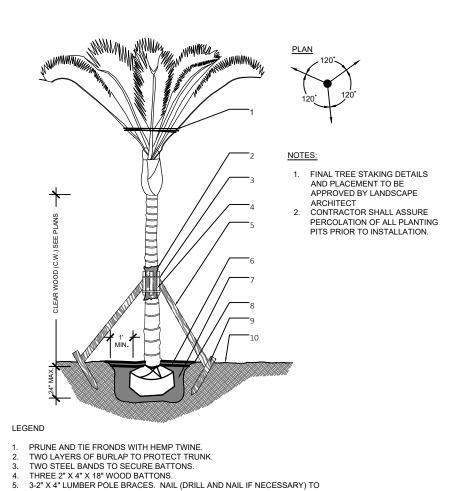


BATTONS & 2" X4" STAKES. FLAG AT MIDPOINT. 3" MIN. MULCH- SEE SPECIFICATIONS.
PREPARED PLANTING SOIL AS SPECIFIED. PALMS SHALL BE PLANTED WITH THE TOP OF ROOTBALL AT FINISHED 2" X 4" X 3' WOOD STAKES

SMALL PALM SCALE: N.T.S

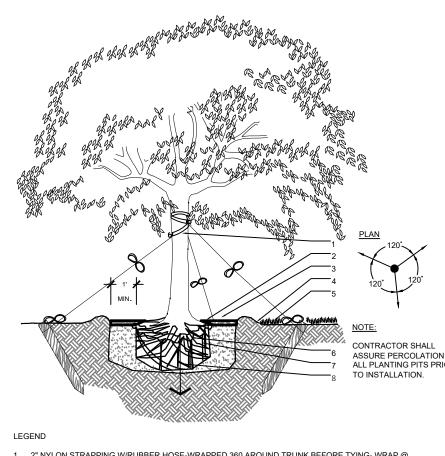

1. 2" NYLON STRAPPING W/RUBBER HOSE-WRAPPED 360 AROUND TRUNK BEFORE TYING- WRAP @ LATERAL BRANCH
3" MULCH AS SPECIFIED MIN. 24" FROM TRUNK


- SOIL BERM TO HOLD WATER 2"x4"x3' STAKES BURIED 3" BELOW FINISHED GRADE FINISHED GRADE - SOD CONDITION (SEE GRADING PLAN B&B OR CONTAINERIZED (SEE SPECIFICATIONS FOR ROOT BALL REQUIREMENTS)
- PREPARED PLANTING SOIL AS SPECIFIED AUGER PER SPECS FOR PERCOLATION
- **LARGE TREE** SCALE: N.T.S

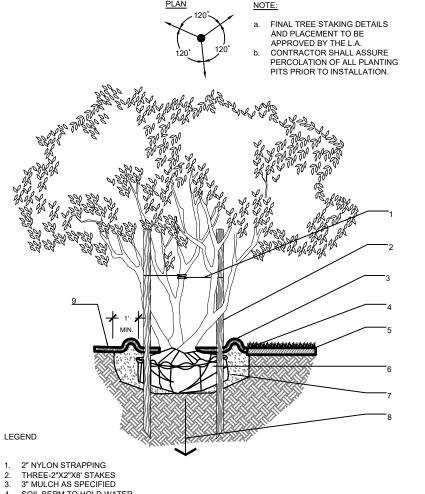

. 2" NYLON STRAPPING SOIL BERM TO HOLD WATER FINISHED GRADE - SOD CONDITION (SEE GRADING PLAN). B&B OR CONTAINERIZED (SEE SPECIFICATIONS FOR ROOT BALL REQUIREMENTS PREPARED PLANTING SOIL AS SPECIFIED

MULCH CONTINUES - SHRUB BED CONDITION

MULTI-TRUNK TREE SECTION SCALE: N.T.S

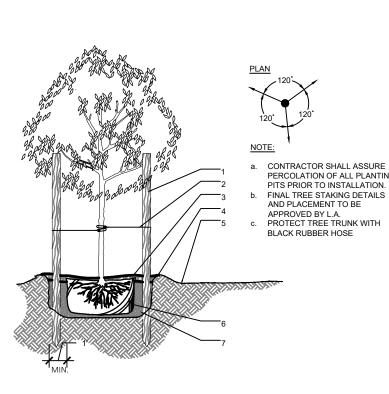


1. THREE 2"x4"x8" STAKES SPACE EVENLY AROUND TREE PAINTED BROWN . #10 GUAGE WIRE. 3" MINIMUM OF MULCH

SOIL BERM TO HOLD WATER FINISHED GRADE (SEE GRADING PLAN).

B&B OR CONTAINERIZED (SEE SPECIFICATIONS FOR ROOT BALL REQUIREMENTS). PREPARED PLANTING SOIL AS SPECIFIED.

SMALL TREE 8 SECTION SCALE: N.T.S

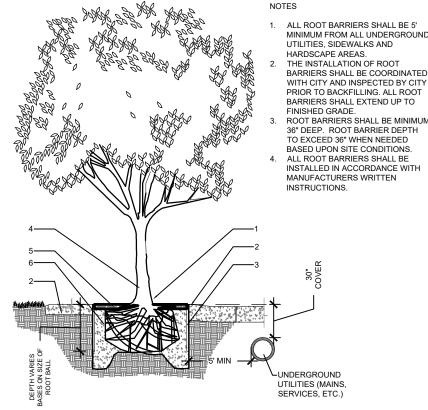


SET ROOT-TRUNK COLLAR FLUSH 1" ABOVE FINISHED GRADE SIDEWALK OR PAVERS
ROOT BARRIER TO EXTEND A MINIMUN 6' IN BOTH DIRECTION FROM

THE CENTERLINE OF THE TREES CENTER TREE IN PLANTER OPENING BACKFILL WITH TOPSOIL OR AMENDED TOPSOIL

ROOT BARRIER INSTALLATION

SCALE: N.T.S

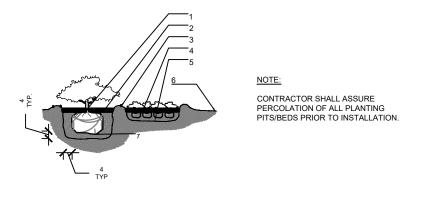


. PLANT MATERIAL SHALL BE PLANTED 2" HIGH WITH SOIL MOUNDING UP TO THE TOP OF ROOT BAL 3" MINIMUM OF MULCH SOIL BERM TO HOLD WATER


EXCAVATE ENTIRE BED SPECIFIED FOR GROUNDCOVER BED FINISHED GRADE (SEE GRADING PLAN) PREPARED PLANTING SOIL AS SPECIFIED

NOTE: WHEN GROUNDCOVERS AND SHRUBS USED IN MASSES, ENTIRE BED TO BE EXCAVATED TO RECEIVE PLANTING SOIL & PLANT MATERIAL, UNLESS NOTED OTHERWISE

10 SHRUBS & GROUNCOVERS SECTION SCALE: N.T.S

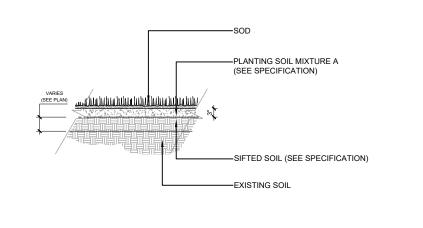


11 SOD SECTION SCALE: N.T.S

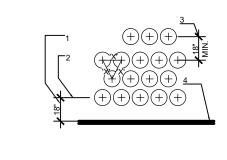

 SETBACK FOR SHRUBS PLANTED 24" O.C. OR GREATER. PROVIDE MIN. 18" SPACING BETWEEN DIFFERENT PLANT TYPES

ALL SHRUBS AND GROUNDCOVER MASSE TO USE TRIANGULAR SPACING EXCEPT WHERE NOTED REFER TO PLANT LIST FOR INDIVIDUAL PLANT SPACING "X".

TYPICAL PLANT SPACING SECTION SCALE: N.T.S

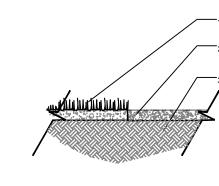

. SOD (PROVIDE CLEAN, SMOOTH EDGE BETWEEN SOD AND MULCHED AREAS). 3" DECORATIVE MULCH. (SEE SPECIFICATIONS PLANTING SOIL (FINE RAKED AND FREE OF WEEDS AND OTHER DELETERIOUS


NOTE: ALL MULCH SHALL BE FREE OF FIRE ANTS AND DEBRIS ONLY

MULCH SCALE: N.T.S

> **Sunshine State** One Call Know what's below. Call before you dig.





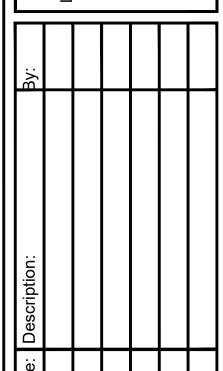

ME

TECTURE, LLC. AND SHALL NOT BE USED, COR

APRIL 17, 2025 Scale: N.T.S. Drawn By: AEM/MEP

Approved By: 202416 Project No: