

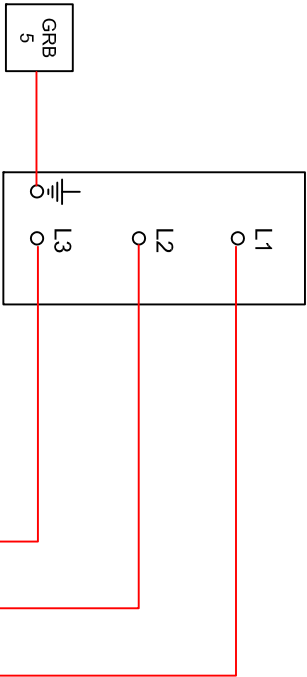


SPD-1

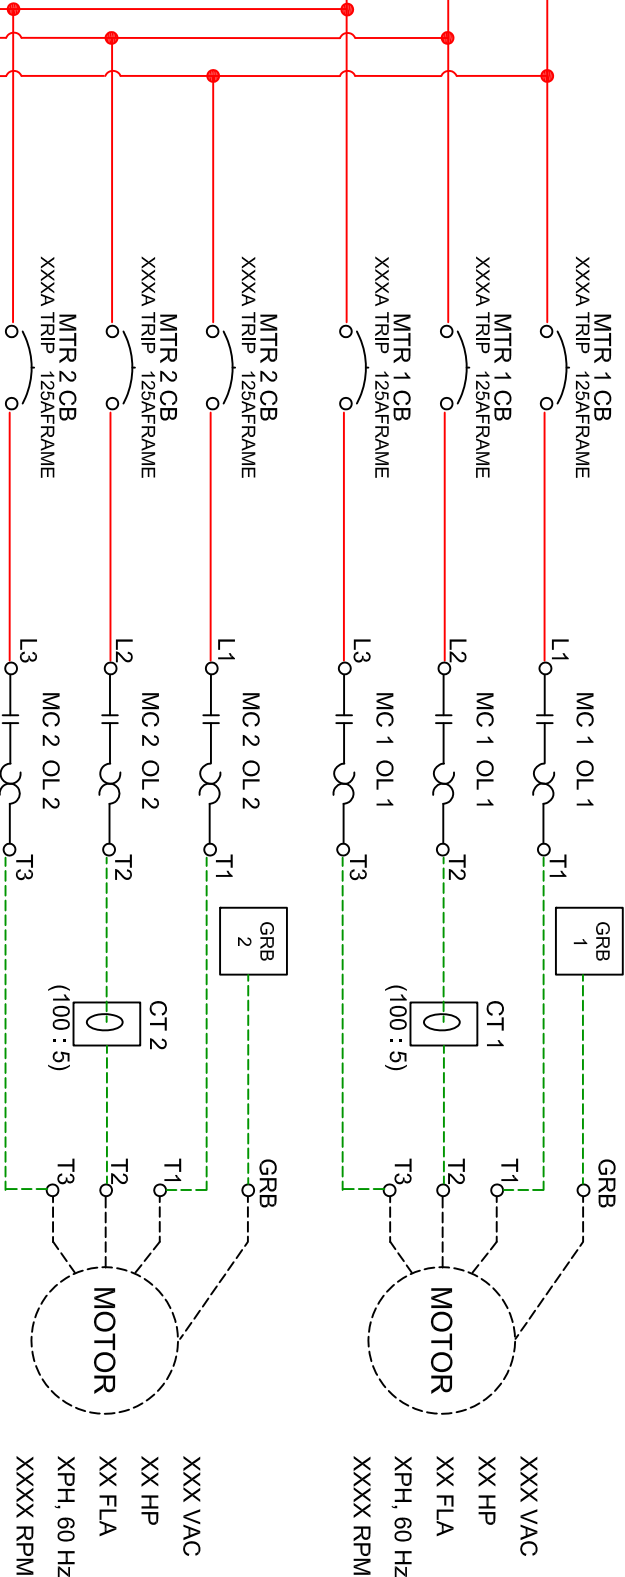


- NOTES:
1. FOR OTHER VOLTAGE CONFIGURATIONS, REFER TO MANUFACTURERS WIRING INSTRUCTIONS. CONTROL POWER TRANSFORMER SHALL BE PROPERLY SIZED FOR APPLICATION. A MINIMUM OF 2000 VA SHALL BE PROVIDED AND MOUNTED EXTERNALLY. REFER TO FRONT ELEVATION AND BILL OF MATERIALS FOR SPECIFIED LOCATION AND SPECIFICATION OF TRANSFORMER.
 2. MOTOR CONTROL WIRING LIMITED TO A MAXIMUM OF:
15 HP @ 230 VOLTS
25 HP @ 460 VOLTS

208VAC
THRU
480VAC
3
PHASE

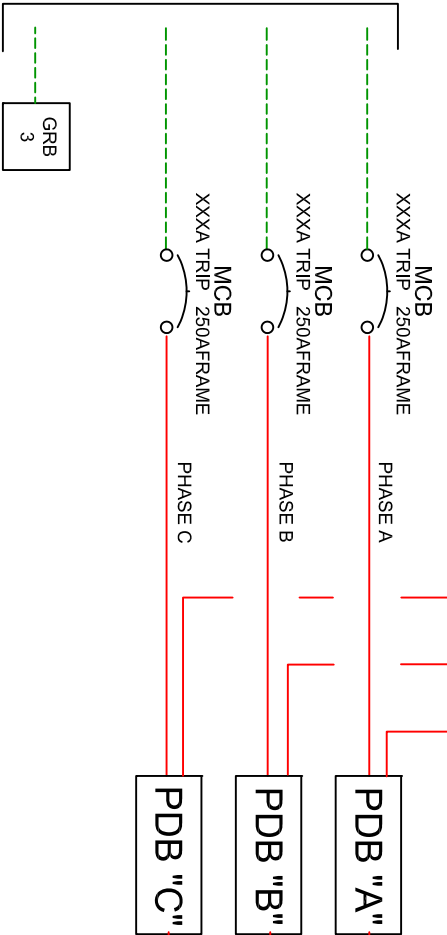


PHM 1

FUB 2

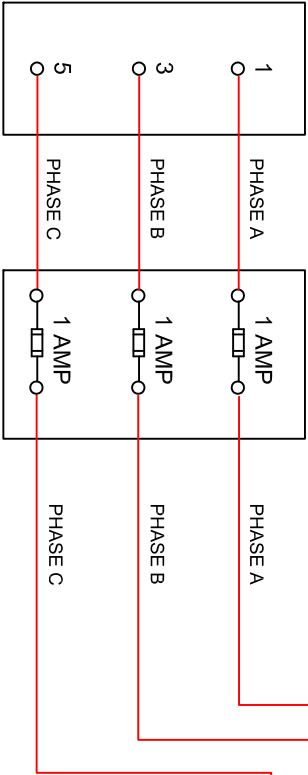

PDB "A"
PDB "B"
PDB "C"

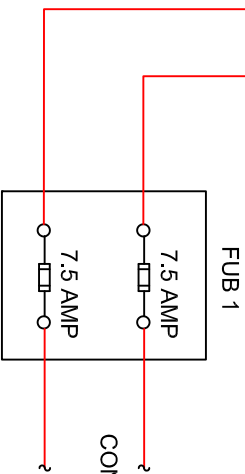

CONTINUED ON DRAWING 207, LINE 700

	SCALE: N.T.S.	-	REVISIONS AS PER MEETING		08-23-2013	JG
	DESIGN: IAG / LS					
	DRAWN BY: JG					
	APPROVED BY: WW	NO	REVISION	DATE	BY	
WASTEWATER DIVISION, INDUSTRIAL AUTOMATION GROUP CITY OF ORLANDO, FLORIDA			TITLE: LIFT STATIONS STANDARDS < 25 HP NEMA STARTER DUPLEX PCP FOR STATIONERY GENERATOR ONE LINE WIRING SCHEMATIC			
SHEET 206B						